


QUEEN CREEK ROAD

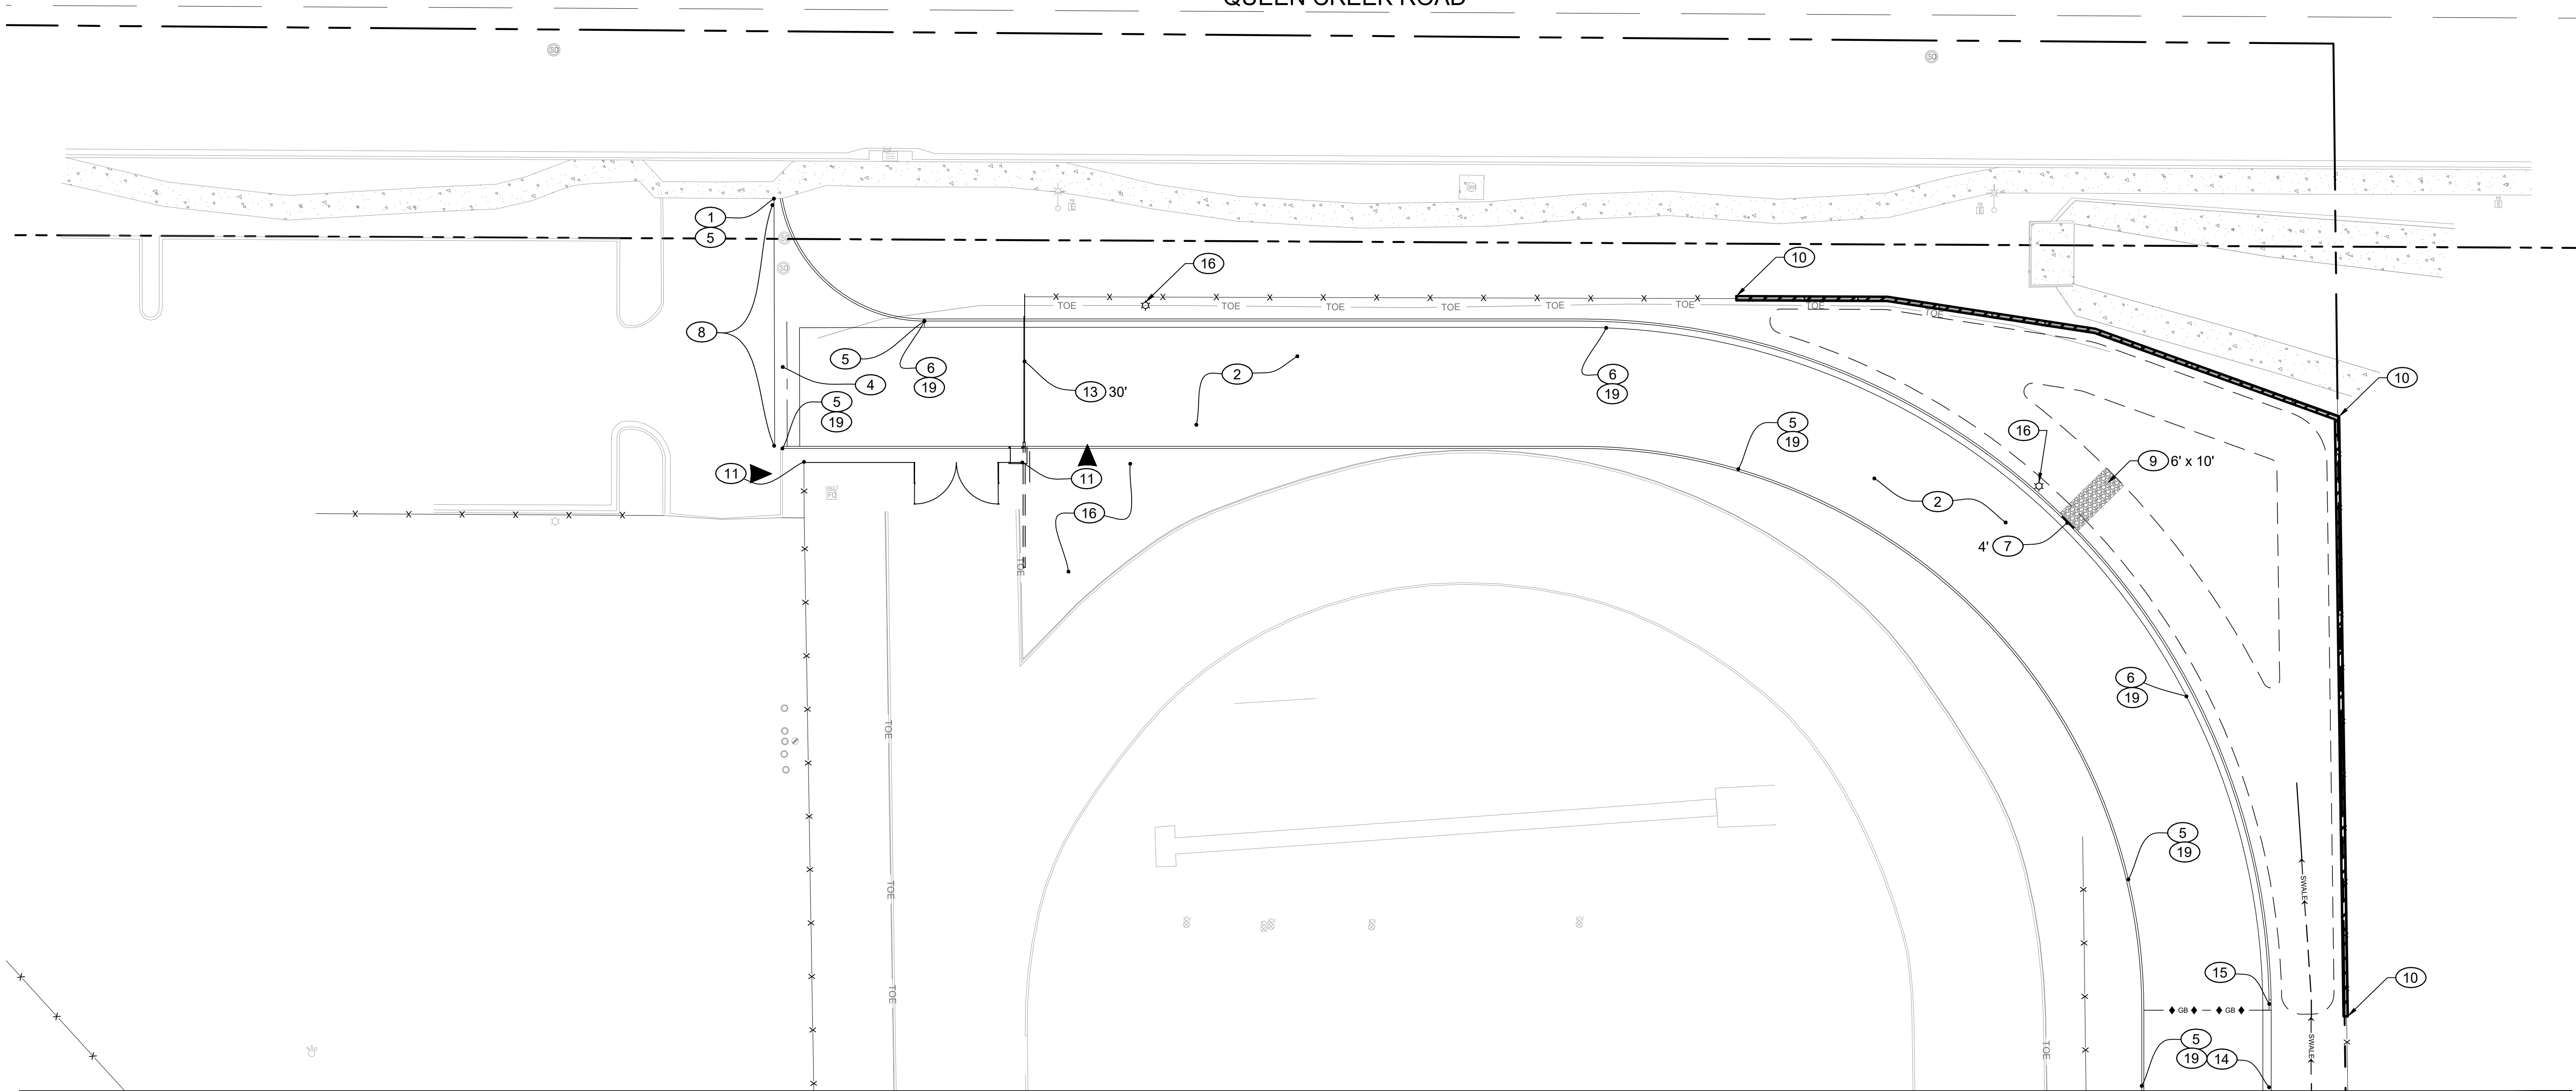

PAVING KEYNOTES:

- CONTRACTOR TO VERIFY ELEVATION OF EXISTING CURB OR SIDEWALK TIE-IN LOCATION AND MATCH EXISTING. NOTIFY ENGINEER OF ANY DISCREPANCIES.
- CONSTRUCT 3" AC OVER 8" ABC OVER 10" COMPACTED SUBGRADE PER MAG SPECIFICATION AND GEOTECHNICAL REPORT REQUIREMENTS. REFER TO DETAIL 1 ON SHEET C5-1.
- CONSTRUCT 12" THICK CONCRETE PAVEMENT, CLASS "A" 3,000 PSI, ON COMPACTED SUBGRADE PER MAG SPECIFICATION AND GEOTECHNICAL REPORT REQUIREMENTS. REFER TO ARCHITECTURAL PLANS FOR FINISH AND COLOR.
- CONSTRUCT 6" WIDE VALLEY GUTTER PER MAG STD. DTL. 240.
- CONSTRUCT 6" SINGLE CURB PER MAG STD. DTL. 222 TYPE "A".
- CONSTRUCT 6" VERTICAL CURB AND GUTTER PER MAG STD. DTL. 220-1 TYPE "A".
- INSTALL CURB OPENING, PER DETAIL 2 ON SHEET C5-1, WIDTH PER PLAN.
- CONSTRUCT ASPHALT THICKEN EDGE PER MAG STD. DTL. 201 TYPE "A".
- INSTALL RIPRAP SPILL WAY PER DETAIL 3 ON SHEET C5-1. LENGTH AND WIDTH PER PLAN.
- CONSTRUCT 2' RETAINING WALL PER ARCHITECTURAL DETAIL.
- INSTALL CHAIN LINK FENCE AND GATES PER ARCHITECTURAL PLANS.
- REFER TO FUELING PLANS FOR TANK, PUMPS, PIPING, AND SAFETY BOLLARDS.
- INSTALL ACCESS GATE, WIDTH PER ARCHITECTURAL PLANS.

- CONSTRUCT 2' RIBBON CURB PER MAG STD. DTL. 220-1 TYPE "B".
- CONSTRUCT SINGLE CURB TERMINATION PER MAG STD. DTL. 222.
- SEE ARCHITECTURAL PLANS FOR HARDSCAPE IMPROVEMENT, FOR LANDSCAPE DETAILS, AND ALL SITE LIGHTING AND DETAILS. COORDINATE CONDUIT PRIOR TO CONCRETE OR PAVING.
- INSTALL 4" SOLID WHITE LINE PER PAVEMENT MARKINGS DETAIL 4 ON SHEET C5-1. DIMENSION OF STRIP PER PLAN VIEW.
- NO ACCESS / NO PARKING 4" SOLID WHITE LINE SPACED 3' AT 45° ANGLE.
- FIRE LANE TO BE IDENTIFIED AND MARKED WITH RED PAINTED CURBING ON VERTICAL FACE OR BACK OF RIBBON CURB WITH THREE (3) INCH WHITE LETTERING WITH A 3/8 INCH STROKE. SPACED AT A MAXIMUM OF FIFTY (50) FEET BETWEEN MARKINGS.

NOTES:

- ENSURE ALL IRRIGATION AND ELECTRICAL SLEEVES ARE INSTALLED PRIOR TO PAVEMENT PLACEMENT.
- COORDINATE ALL SLEEVES WITH ELECTRICAL AND LANDSCAPE PLANS.

MATCHLINE SEE PAVING SHEET C4-2

CONSTRUCTION
DOCUMENTS



REV.

QUEEK CREEK JH
TRANSPORTATION
CENTER ADDITION


20948 E. QUEEN CREEK ROAD
QUEEN CREEK, AZ 85142

DESIGNED: JLP
DATE: FEB. 21, 2025
DRAWN: JI
PROJ. 24-124
SCALE: 1" = 20'

PAVING PLAN

DWG. NO.

C4-1

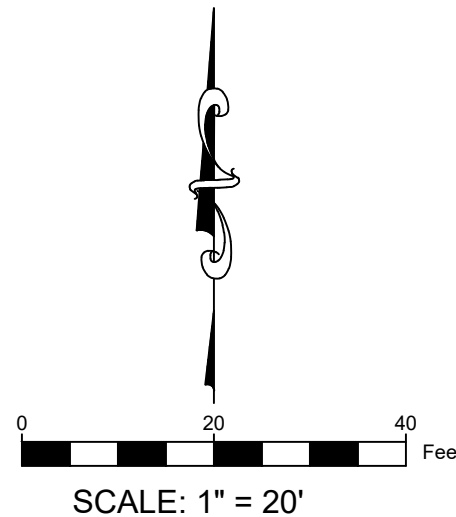

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MATCHLINE SEE PAVING SHEET C4-1

MATCHLINE SEE PAVING SHEET C4-3


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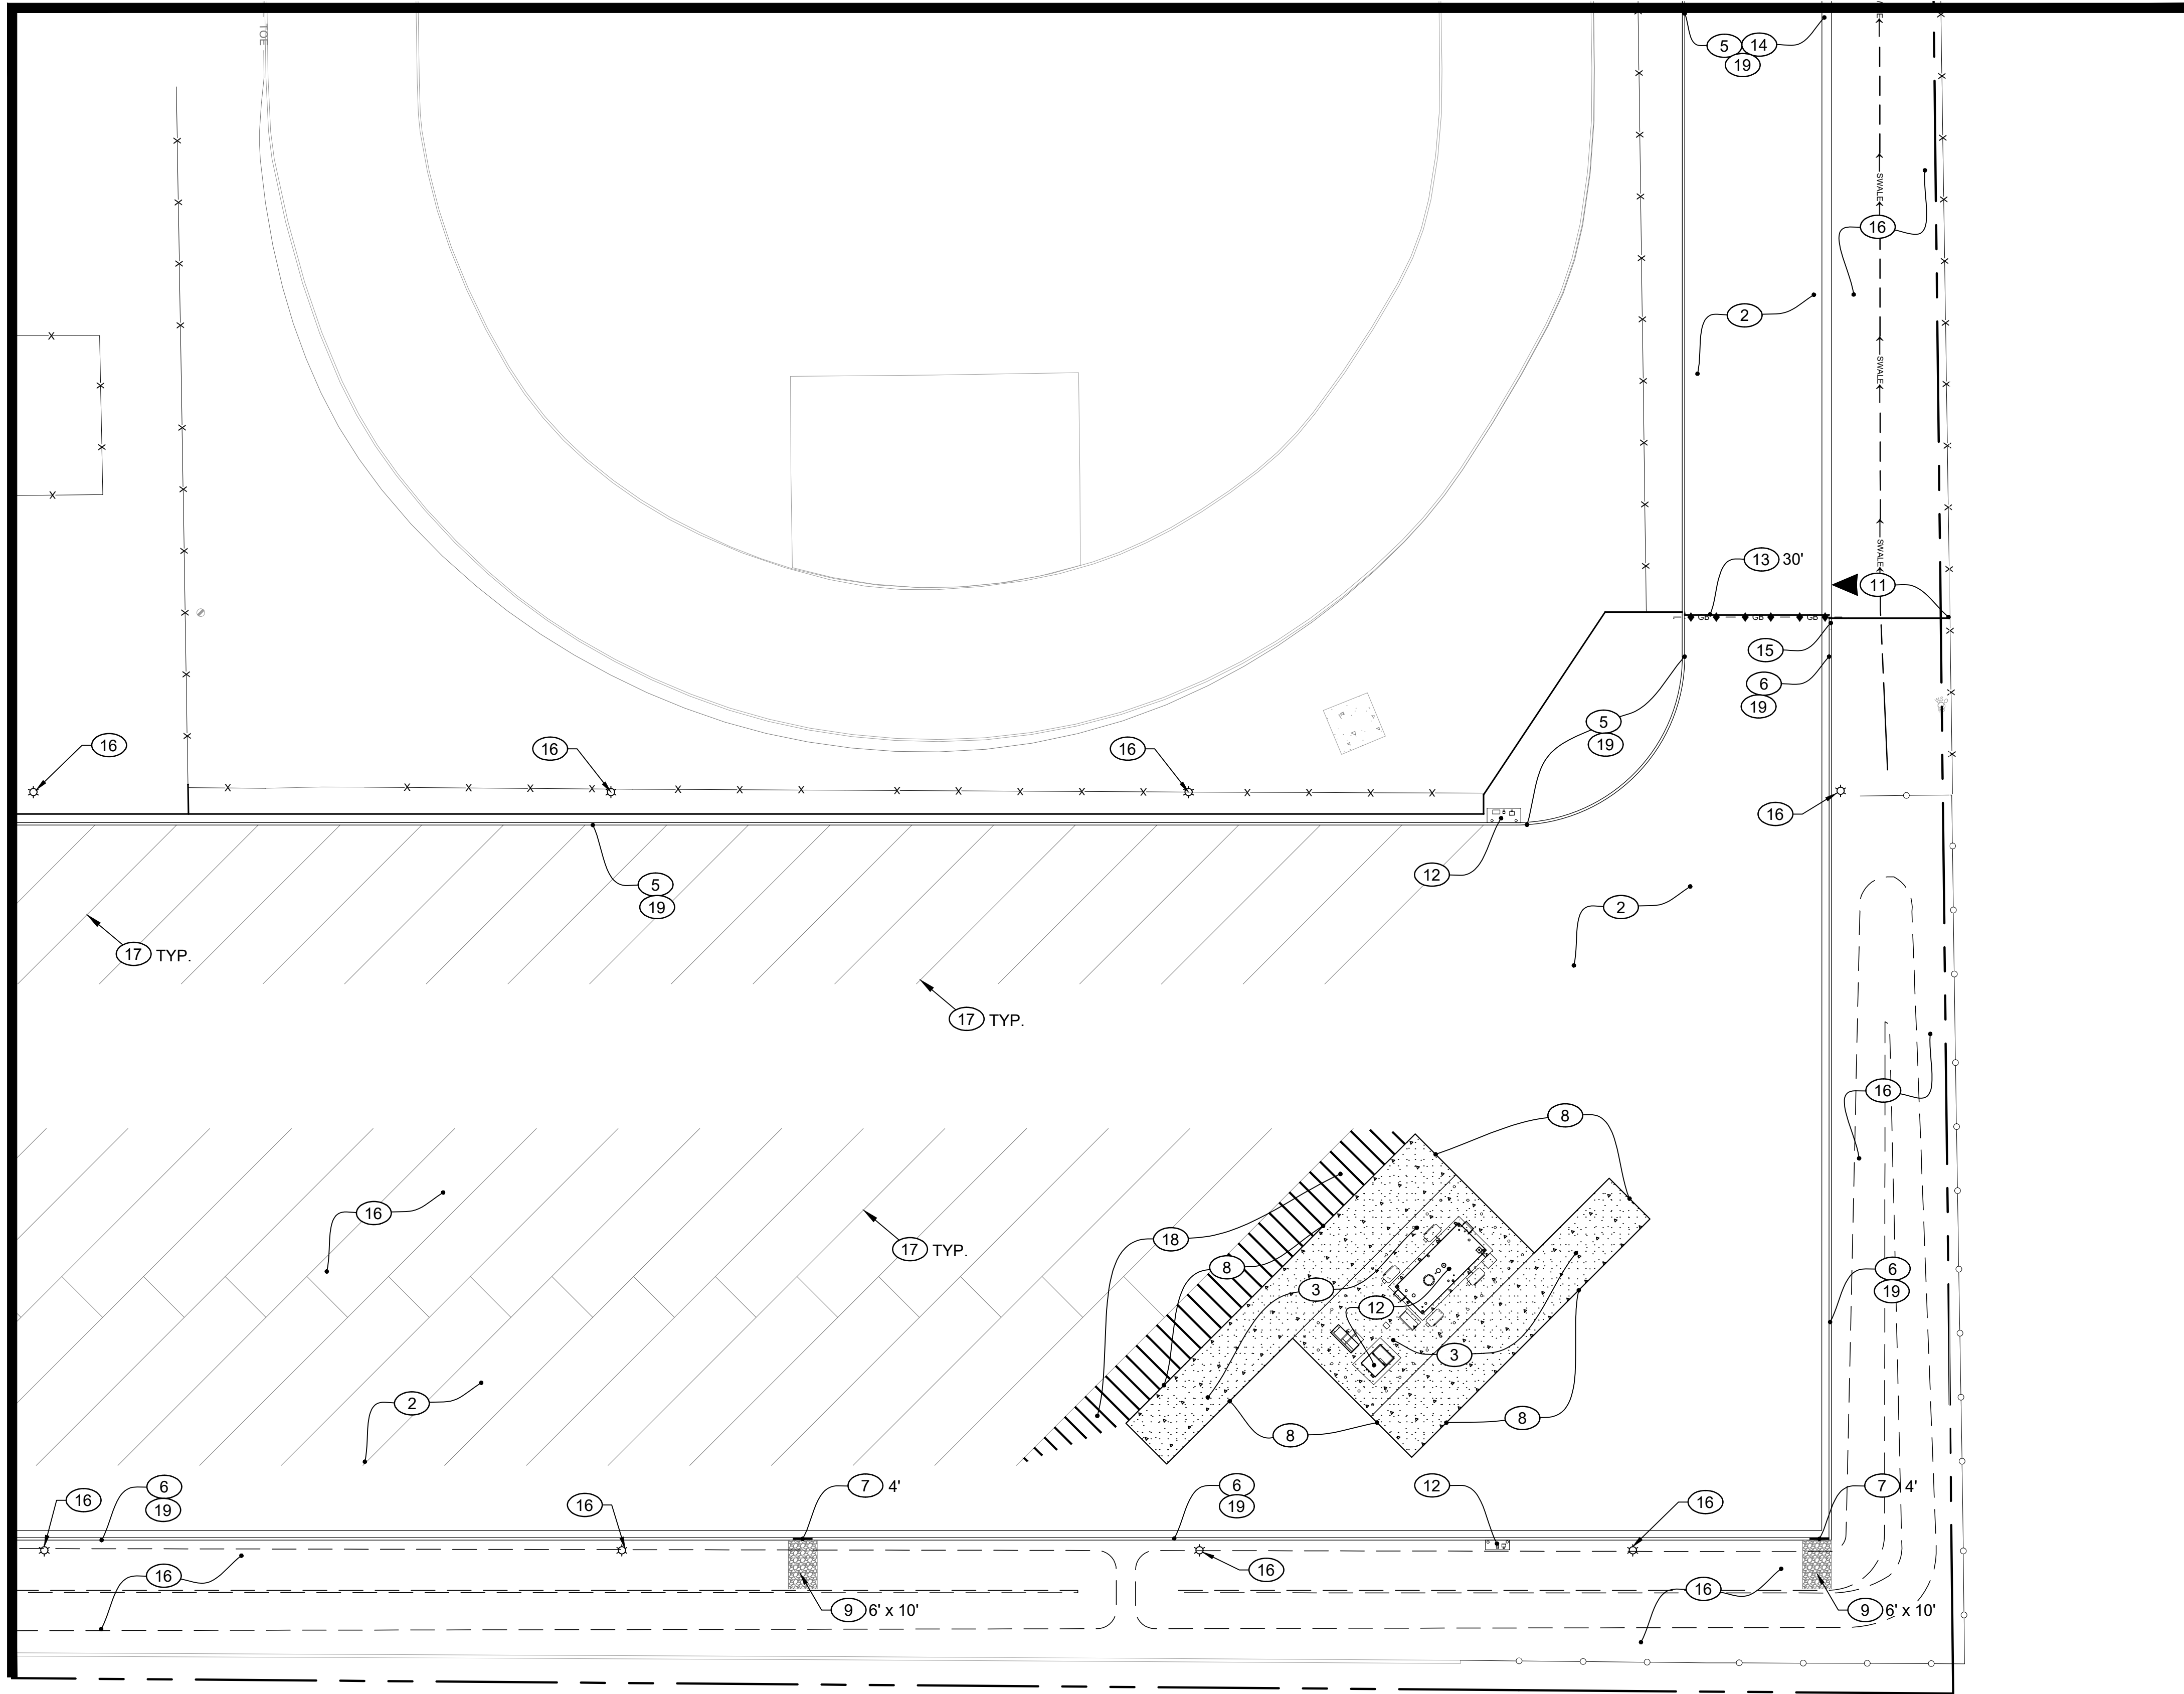
PAVING PLAN

DWG. NO.

C4-2

MATCHLINE SEE PAVING SHEET C4-2

MATCHLINE SEE PAVING SHEET C4-4

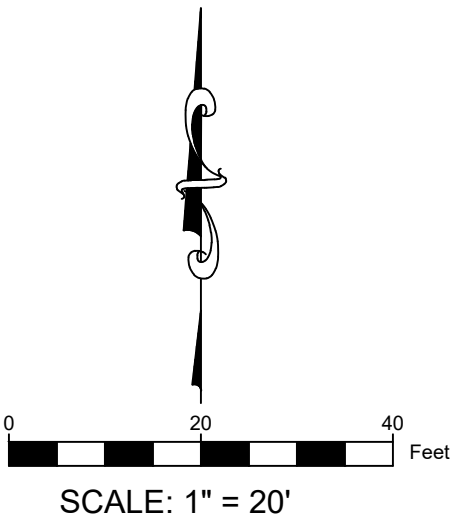

PAVING KEYNOTES:

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CONSTRUCTION DOCUMENTS



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**QUEEK CREEK JH
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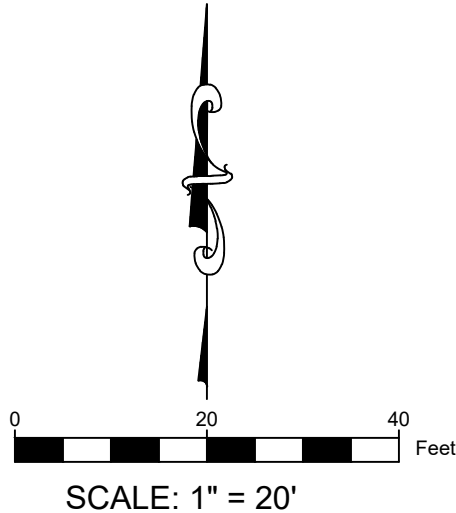
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PAVING PLAN

DWG. NO.

C4-3



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MATCHLINE SEE PAVING SHEET C4-3

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